Appendix I

規劃署

粉嶺、上水及元朗東規劃處 新界荃灣青山公路 388 號 中梁大廈 22 棲 2202 室



Planning Department

Fanling, Sheung Shui & Yuen Long East
District Planning Office
Unit 2202, 22/F., CDW Building,
388 Castle Peak Road, Tsuen Wan, N.T.

來函檔號

Your Reference :

DD125 Lot 107 & VL

本署檔號

Our Reference:

TPB/A/YL-KTN/957

继结合统而

Tel. No.:

傳真機號碼

Fax No.:

By Post and Fax (2323 3662)

R-riches Property Consultants _imited Block D, The Richfield 236 Kat Hing Wai Kam Tin, New Territories (Attn.: Mr. Orpheus LEE / Ms. Grace WONG)

9 January 2024

Dear Sir/Madam,

Submission for Compliance with Approval Condition (g)

- the Submission of Fire Service Installations Proposal

Proposed Temporary Warehouse (excluding Dangerous Goods Godown) with
Ancillary Facilities for a Period of 3 Years and Filling of Land
in "Agriculture" Zone, Lots 1424 (Part), 1426 (Part), 1427 (Part) and 1428 (Part) in
D.D. 107 and Adjoining Government Land, Kam Tin, Yuen Long, New Territories
(Application No. A/YL-KTN/957)

I refer to your submission dated 27.11.2023 for compliance with the captioned approval condition. Relevant department has been consulted on your submission. Your submission is considered:

\checkmark	Acceptable.	The caption	ned cond	lition <u>has</u>	been	complied	with.	Please	find
	detailed departmental comments in Appendix.								

- Acceptable. Since the captioned condition requires both the submission and implementation of the proposal, it has not been fully complied with. Please proceed to implement the accepted proposal for full compliance with the approval condition.
- Not acceptable. The captioned condition has not been complied with.

Should you have any queries, please contact Mr. CHEUNG Wing-hei (Tel: of the Fire Services Department directly.

Yours faithfully,

(KWNG)

District Planning Officer/
Fanling, Sheung Shui & Yuen Long East
Planning Department

透過規劃工作,使香港成為一個宜居、具競爭力和可持續發展的**亞洲國際都會** We plan to make Hong Kong a Liveable • Competitive • Sustainable ASIA'S WORLD CITY 15:53

2 -

Internal CTP/TPB

10-JAN-2024

KWN/AY/on

Comments from the Director of Fire Services:

Please be advised that the installation/maintenance/modification/repair work of FSIs shall be undertaken by a Registered Fire Service Installation Contractor (RFSIC). The RFSIC shall after completion of the installation/maintenance/modification/repair work issue to the person on whose instruction the work was undertaken a certificate (F.S. 251) and forward a copy of the certificate to the Director of Fire Services.



Our Ref.: DD125 Lot 107 & VL Your Ref.: TPB/ A/YL-KTN/957 顧問有限公司 **盈卓物業**

The Secretary
Town Planning Board
15/F, North Point Government office
333 Java Road
North Point, Hong Kong

By Email

27 November 2023

Compliance with Approval Condition (g)

Proposed Temporary Warehouse (excluding Dangerous Goods Godown) with Ancillary Facilities for a Period of 3 Years and Filling of Land in "Agriculture" Zone, Various Lots in D.D. 107, Kam Tin, Yuen Long, New Territories

(S.16 Planning Application No. A/YL-KTN/957)

We are writing to submit a FSIs proposal (**Appendix I**) for compliance with approval condition (g) of the subject application, i.e. the submission of the fire services proposal. Your kind attention to the matter is much appreciated.

Should you require more information regarding the application, please contact our or the undersigned at your convenience.

Yours faithfully,

For and on behalf of

R-riches Property Consultants Limited

Órpheus LEE

Planning and Development Consultant





DEVELOPMENT PARAMETERS APPLICATION SITE AREA : 2.683 m² (ABOUT) COVERED AREA : 1.136 m² (ABOUT) UNCOVERED AREA : 1,547 m² (ABOUT)

PLOT RATIO : 0.42 (ABOUT) SITE COVERAGE : 42 % (ABOUT)

NO. OF STRUCTURE

DOMESTIC GFA : NOT APPLICABLE

NON-DOMESTIC GFA : 1,136 m² (ABOUT) (ABOUT) TOTAL GFA : 1.136 m²

BUILDING HEIGHT : 3 m - 7 m (ABOUT)

NO. OF STOREY

PARKING AND LOADING / UNLOADING PROVISIONS

NO. OF PRIVATE CAR

PARKING SPACE

DIMENSION OF PARKING SPACE : 5 m (L) x 2.5 m (W)

NO. OF L/UL SPACE FOR

LIGHT GOODS VEHICLE

DIMENSION OF L/UL SPACE : 7 m (L) x 3.5 m (W)

FIRE SERVICE INSTALLATIONS




EXIT SIGN AND EMERGENCY LIGHT



5 KG DRY POWDER TYPE FIRE EXTINGUISHER

FS NOTES:

- 1. SUFFICIENT EMERGENCY LIGHTING SHALL BE PROVIDED THROUGHOUT THE ENTIRE BUILDING IN ACCORDANCE WITH BS5266-1:2016 AND BS EN1838:2013 AND FSD CIRCULAR LETTER 4/2021
- SUFFICIENT DIRECTIONAL AND EXIT SIGN SHALL PROVIDED IN ACCORDANCE WITH BS5266-1:2016 AND FSD CIRCULAR LETTER 5/2008.
- 3. PORTABLE HAND-OPERATED APPROVED APPLIANCE SHALL BE PROVIDED AS REQUIRED BY OCCUPANCY.
- ACCESS IS PROVIDED FOR EMERGENCY VEHICLE TO REACH 30m OF ALL PART OF STRUCTURES.

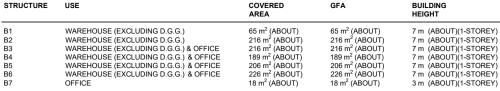

1,136 m2 (ABOUT)

LEGEND


APPLICATION SITE

PARKING SPACE

LOADING / UNLOADING SPACE

STRUCTURE

INGRESS / EGRESS

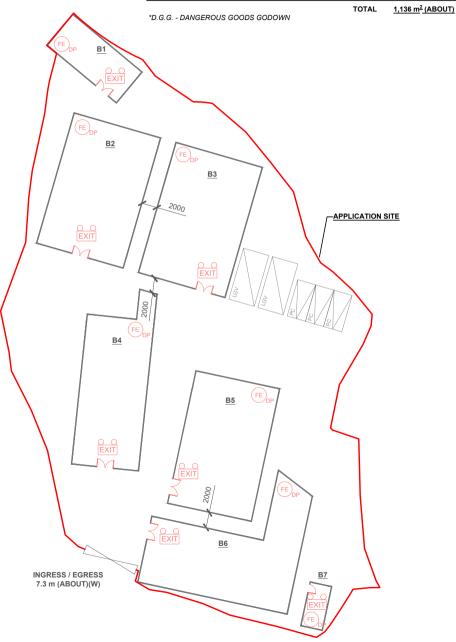







PROPOSED TEMPORARY WAREHOUSE (EXCLUDING DANGEROUS GOODS GODOWN) WITH ANCILLARY FACILITIES FOR A PERIOD OF 3 YEARS AND ASSOCIATED FILLING OF LAND

VARIOUS LOTS IN D.D. 107 AND ADJOINING GOVERNMENT LAND, KAM TIN, YUEN LONG, **NEW TERRITORIES**


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: 500 @ A4	
RAWN BY	DATE
DL	27.11.2023
EVISED BY	DATE
PROVED BY	DATE
VG. TITLE	
SIs PROPOSAL	


APPENDIX


<u>Appendix II – Response to the Previous Comments of Chief Engineer/Mainland North, Drainage Services Department (CE/MN, DSD)</u>

Com	Comments of the CE/MN, DSD						
(Con	tact Person:)						
(1)	Fig. 1 - There are two CP7.	It is revised accordingly (Annex I).					
(2)	Connection details - CP9 is not connecting to existing stream as shown in the drainage layout plan. All proposed invert levels should be given.	Connnection details of CP10 is revised and all proposed invert levels should be given (Annex I).					
(3)	GEO TGN No. 42 - 375UC appears to be undersized in the chart. Please upgrade the UC size for conservative concern.	Proposed 375UC has been upgraded its size as 450UC (Annex I).					
(4)	Please clarify the relationship between view 2 and view 3. It is noted that there are already few underground pipes in view 3, please clearly advise how the proposed discharge pipe would not affect the existing underground pipes.	Underground pipe will be reconstructed as 450mm dia. UPVC due to insufficient capacity of original pipe (Annex I).					
(5)	The proposed outlet pipe size does not tally with all plans/ connection details. Please review.	It is revised accordingly that proposed outlet pipe size does tally with all plans and connection detail (Annex I).					



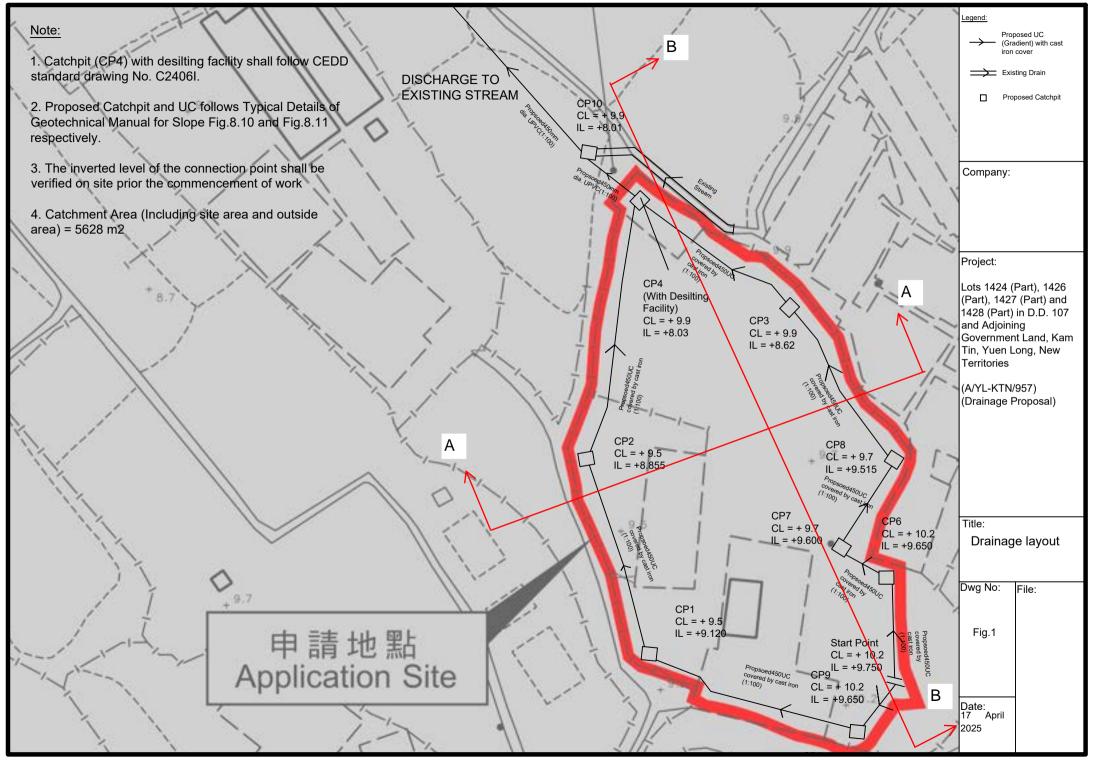

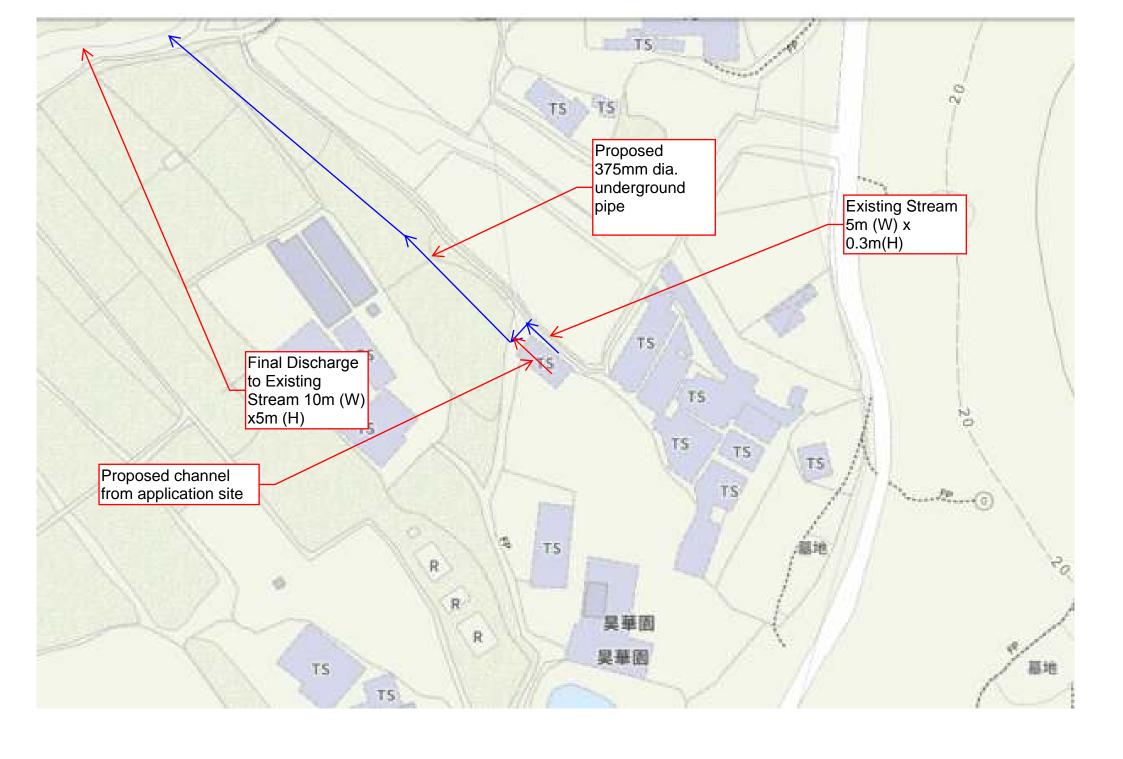

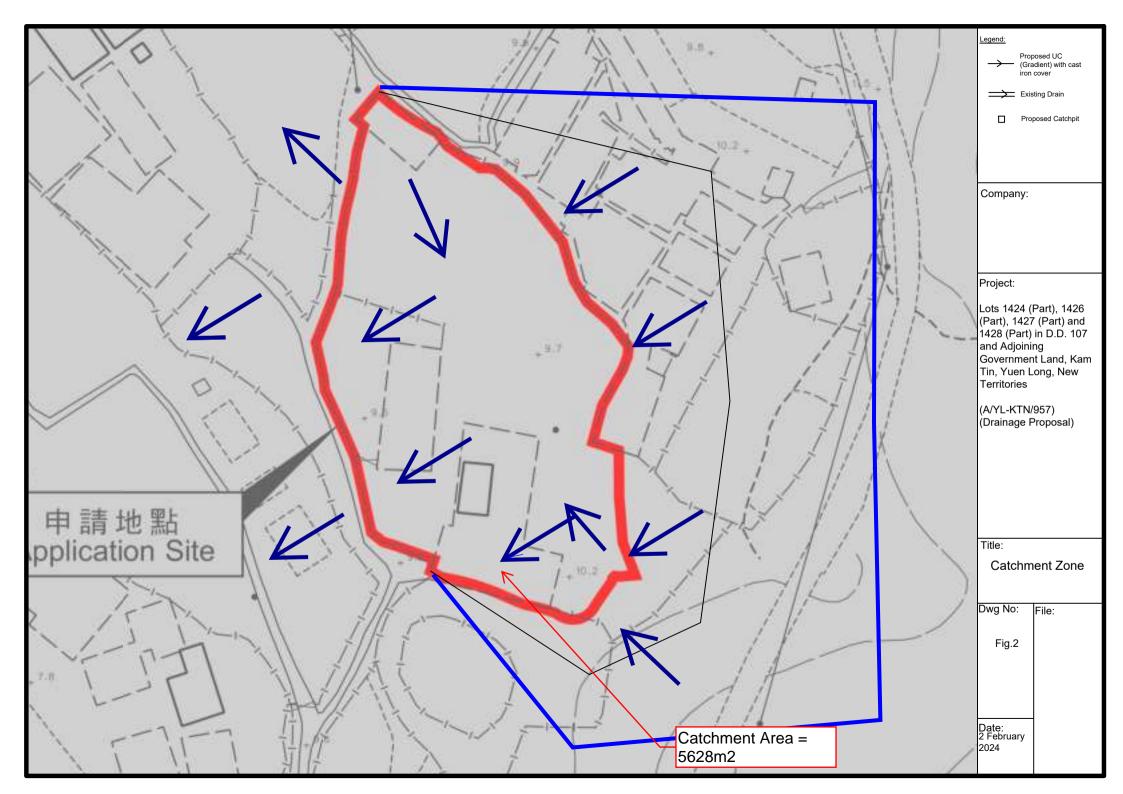

Assume return period T = 50years

According to SDM Corrigendum No.1 /2024

$$a = 505.5$$
, $b = 3.29$, $c = 0.355$

$$i = \frac{a}{(td+b)C}$$

Duration in minutes is taken as 6 mins

According to SDM Corrigendum No.1 /2022 , rainfall increase = 16%

$$i = (505.5)$$
 $(1+16\%)$ = 229 x (1+16%) = 266 mm/hr

i = 266 mm/hr is taken

Catchment Area = 2683m² (Site Area), Catchment area = 2945m² (Outside area)

Surface runoff coeficient C = 0.95 (Site Area) and C = 0.4 (for outside catchment area)

Qp= 0.278CiA

= 0.2756m3/s = 16536litre /min

Slopes GEO Technical Guidance Note No. 43 (TGN 43) Guidelines on Hydraulic Design of U-shaped and Half-round Channels on




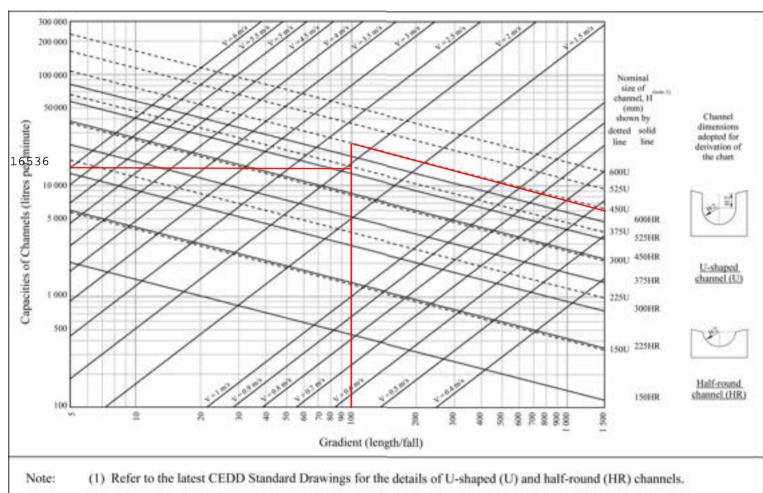


Figure 1 - Chart for the rapid design of U-shaped and half-round channels up to 600 mm

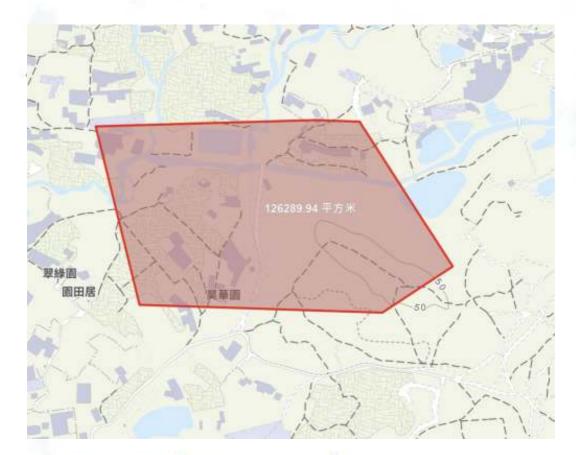

Catchment Area = 126290m2

$$Q = 0.278 \text{ Ci A}$$

= 0.278 (0.45)(250) (126290 x 10^-6)
= 8.338m3/hr

10m (W) x 5m(H) existing channel is final discharge Port

By Manning's Equation, $Q = \frac{1}{n} \frac{A^{\frac{2}{5}}}{p^{\frac{2}{3}}} S_0^{\frac{1}{2}} \quad \text{where} \quad n = 0.015$ $S_0 = 0.001$ $A = 10 \times 5 = 50 \text{m}^2$ $P = 10 \times 2 + 5 = 25 \text{m}$


= 167.3m3/hr

> 8.338m3/hr

APPLICATION SITE AREA COVERED AREA UNCOVERED AREA	2,683 m ² 1,136 m ² 1,647 m ³	(ABOUT) (ABOUT)
PLOT RATIO SITE COVERAGE	: 0.42 -42%	(ABOUT)
NO. OF STRUCTURE. DOMESTIC GFA NON-DOMESTIC GFA TOTAL GFA	7 NOT APPLIC 1,130 m ² 1,136 m ²	ABLE (ABOUT) (ABOUT)
BUILDING HEIGHT NO. OF STOREY	3m-7m (

STRUCTURE	USE	COVERED AREA	GFA	BUILDING HEIGHT
01 82 93 94 95 96 97	WAREHOUSE (EXCLUDING D.G.G.) WAREHOUSE (EXCLUDING D.G.G.) WAREHOUSE (EXCLUDING D.G.G.) & OFFICE WAREHOUSE (EXCLUDING D.G.G.) & OFFICE WAREHOUSE (EXCLUDING D.G.G.) & OFFICE OFFICE OFFICE	65 m² (ABOUT) 216 m² (ABOUT) 216 m² (ABOUT) 109 m² (ABOUT) 206 m² (ABOUT) 225 m² (ABOUT) 18 m² (ABOUT)	65 m² (ABOUT) 216 m² (ABOUT) 216 m² (ABOUT) 185 m² (ABOUT) 226 m² (ABOUT) 18 m² (ABOUT) 18 m² (ABOUT)	T = (ABOUT)(1-STOREY)
	2000	a sas - Language	a ann Lamestern	



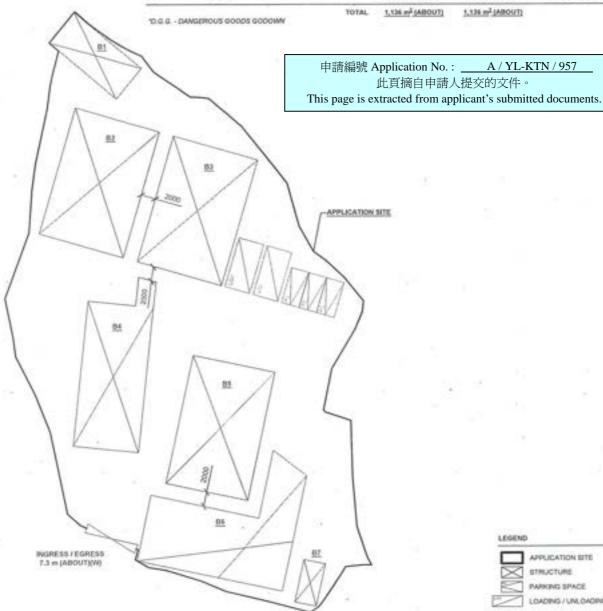



WAREHOUSE DANGEROUS GOODS GODOWNS WITH ANCILLARY FACILITIES FOR A PERIOD OF 3 YEARS AND ASSOCIATED FILLING OF LAND

VARIOUS LOTS IN D.D. 187 AND ADJOINING GOVERNMENT LAND, KAM TIN, YUEN LONG, NEW TERRITORIES

DAMES PT	SHE.
MN	15.8.2023
REVOKERY	308
OL.	24.8.2023
PERMIT	2001

901

LAYOUT PLAN

PLAN 4

LEGEND

APPLICATION SITE

STRUCTURE

PMGRESS/EGRESS

PARKING SPACE

LOADING / UNLOADING SPACE

PARKING AND LOADING / UNLOADING PROVISIONS

NO. OF PRIVATE CAR PARKING SPACE DIMENSION OF PARKING SPACE

5 m (i) x 2.5 m (W)

NO. OF LAIL SPACE FOR LIGHT GOODS VEHICLE. DIMENSION OF LAX, SPACE

2 7 m (U x 2.5 m (W)

APPLICATION SITE BEFORE FILLING OF LAND

APPLICATION SITE AREA SITE LEVELS BEFORE FILLING OF LAND 2,683 m³ +9.3 mPO TO +10.0 mPO (ABOUT)

EXISTING FELLING OF LAND AREA

APPLICATION SITE AREA COVERED BY STRUCTURE. (ABOUT) (ABOUT) (ABOUT)

EXISTING FILLED AREA DEPTH OF LAND FILLING PROPOSED SITE LEVELS MATERIAL OF LAND FILLING 2,683 m² NOT MORE THAN 0.2 m +9.5 mPD TO +10.2 mPD

CONCRETE


2,665 m

1,136 m

SITE FORMATION OF STRUCTURES.

AND CIPICULATION SPACE

THE APPLICATION SITE HAS BEEN FILLED WITH CONCRETE. NO FURTHER PILLING OF LAND WILL BE CARRIED OUT AT THE SITE DURING THE PLANNING APPROVAL PERIOD.

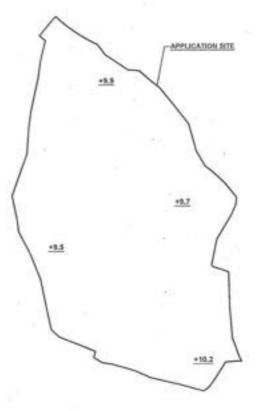



PROPOSED WAREHOUSE DANGEROUS GOODS GODOWAG WITH ANCELARY FACILITIES FOR A PERIOD OF 3 YEARS AND ASSOCIATED FILLING OF LAND

PLANS.

LEGEND

APPLICATION SITE

LAND FILLING AREA

23.4 SITE LEVEL

VARIOUS LOTS IN D.D. 167 AND ADJOINING GOVERNMENT LAND, KAM TIN, YUEN LONG, NEW TERRITORIES

Apple Sec	15.8.2023
WE WANTED	15.8.2023
4	24.6.2023
HEREIT	100

801

APPLICATION SITE +9.7 +9.5 +9.3 +10.0


申請編號 Application No.: _____ A / YL-KTN / 957 此頁摘自申請人提交的文件。 This page is extracted from applicant's submitted documents.


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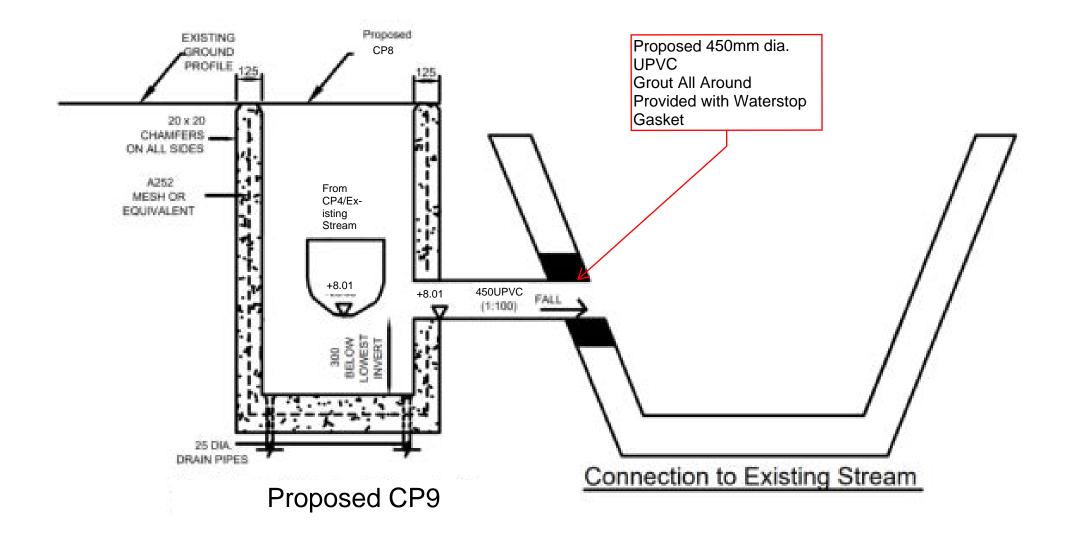
APPLICATION SITE

+3.4 SITE LEVEL

SITE LEVELS ARE FOR REFERENCE ONLY



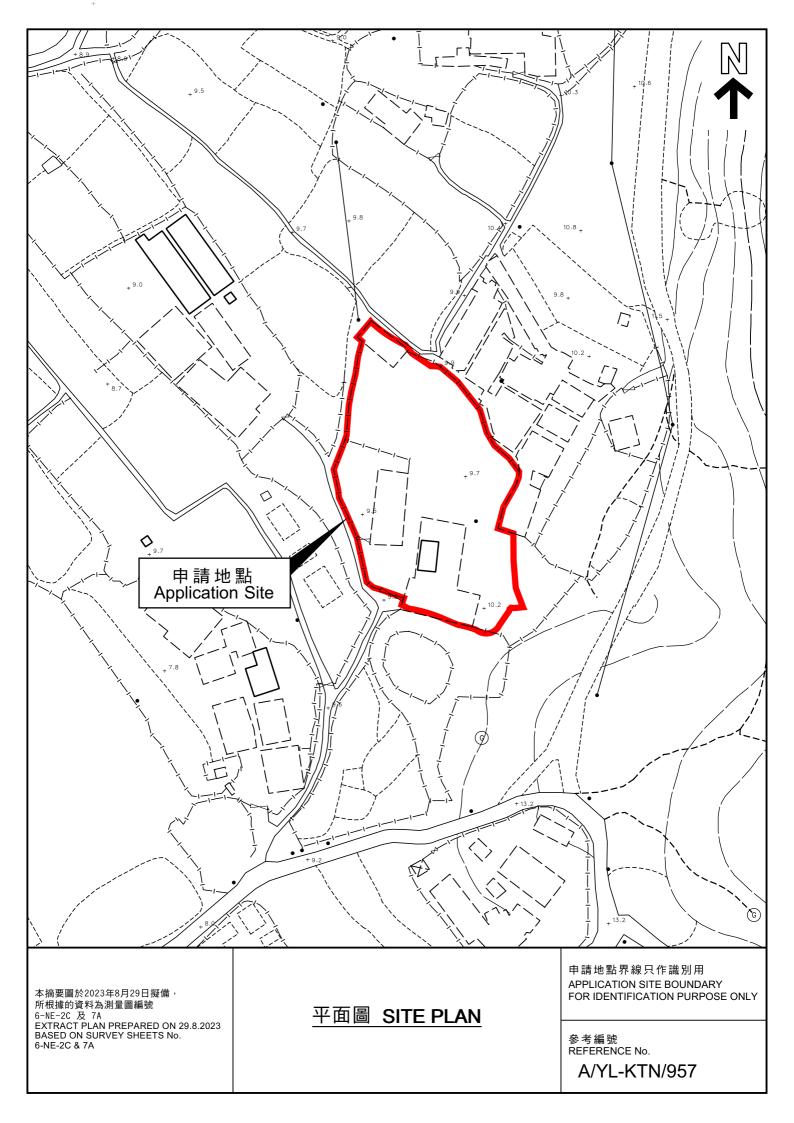

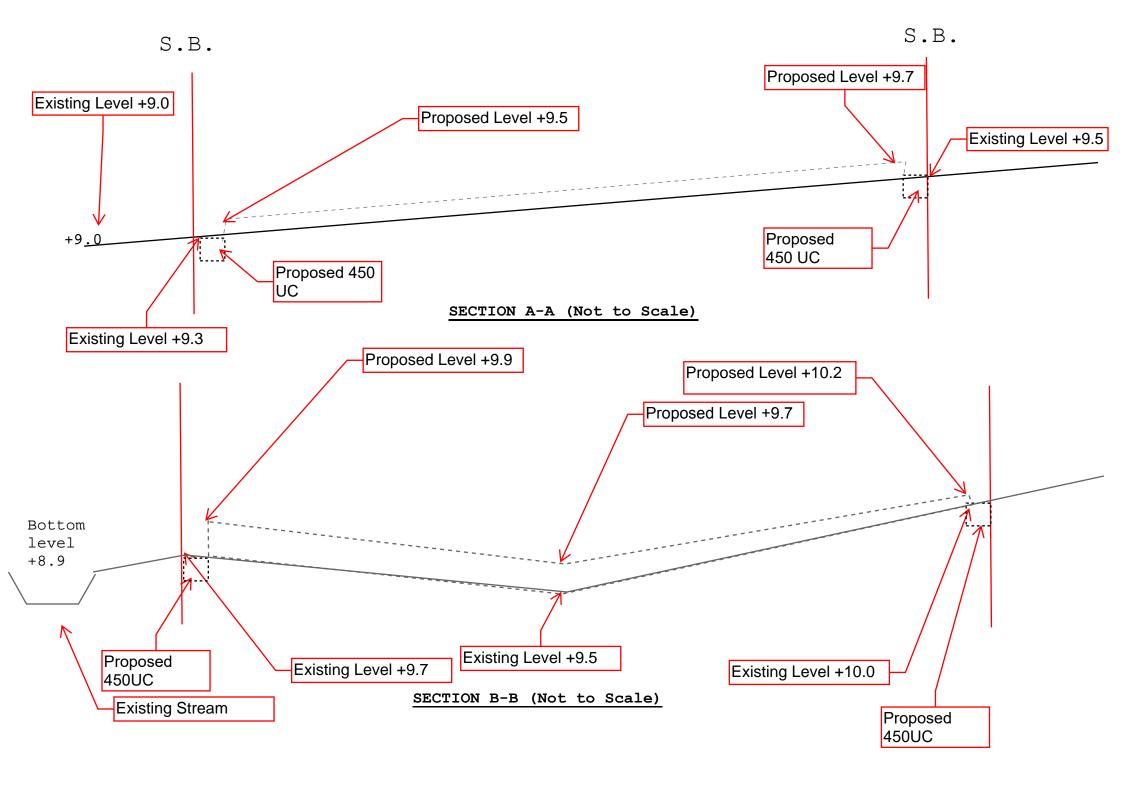

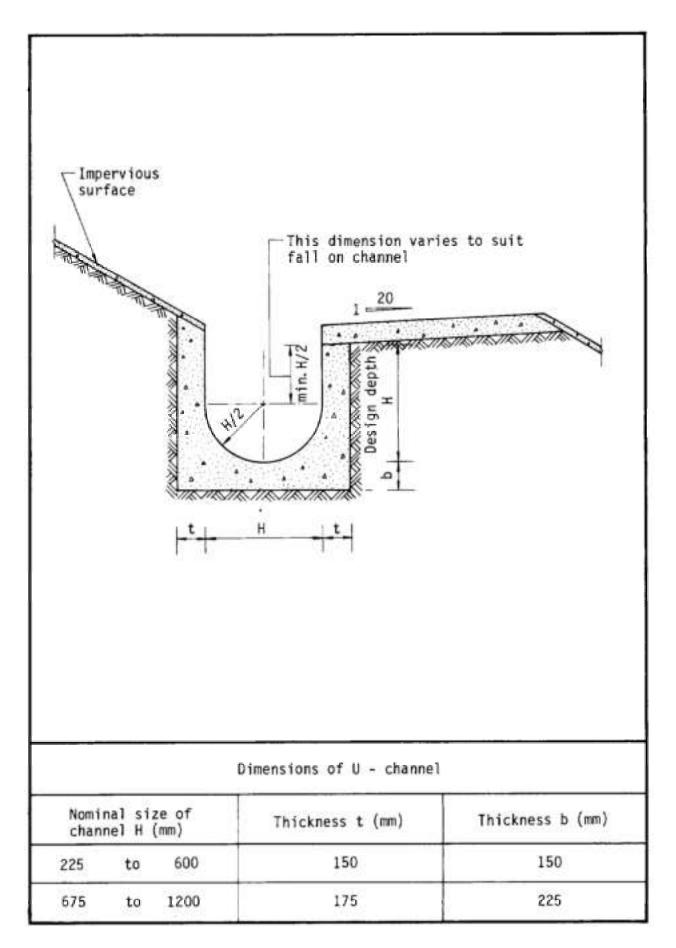


Figure 8.11 - Typical U-channel Details


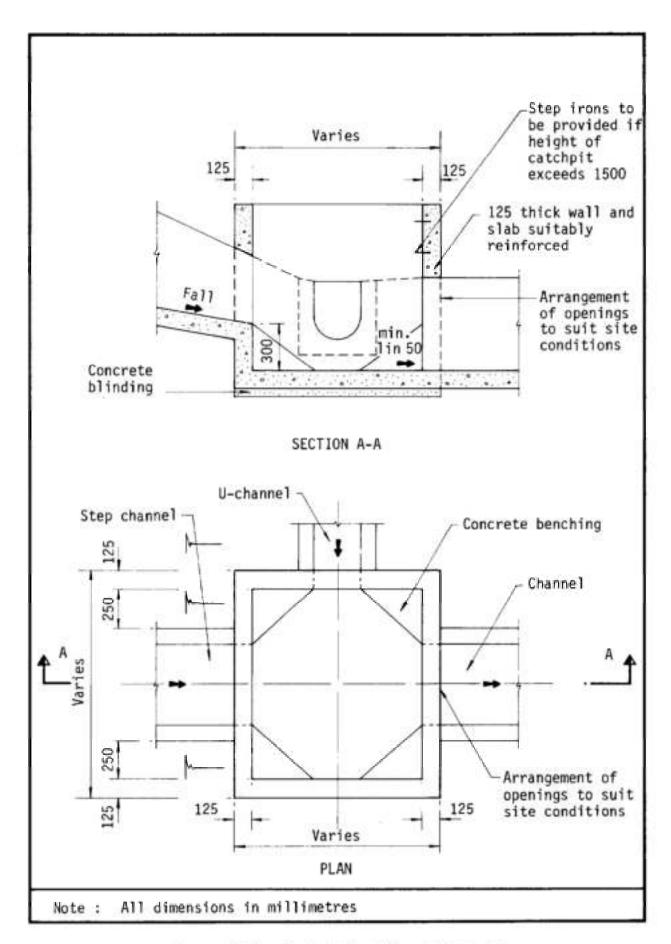


Figure 8.10 - Typical Details of Catchpits

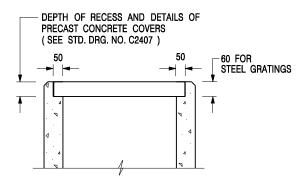

ALTERNATIVE TOP SECTION FOR PRECAST CONCRETE COVERS / GRATINGS

NOTES:

- 1. ALL DIMENSIONS ARE IN MILLIMETRES.
- 2. ALL CONCRETE SHALL BE GRADE 20 /20.
- 3. CONCRETE SURFACE FINISH SHALL BE CLASS U2 OR F2 AS APPROPRIATE.
- 4. FOR DETAILS OF JOINT, REFER TO STD. DRG. NO. C2413.
- 5. CONCRETE TO BE COLOURED AS SPECIFIED.
- UNLESS REQUESTED BY THE MAINTENANCE PARTY AND AS DIRECTED BY THE ENGINEER, CATCHPIT WITH TRAP IS NORMALLY NOT PREFERRED DUE TO PONDING PROBLEM.
- 7. UPON THE REQUEST FROM MAINTENANCE PARTY, DRAIN PIPES AT CATCHPIT BASE CAN BE USED BUT THIS IS FOR CATCHPITS LOCATED AT SLOPE TOE ONLY AND AS DIRECTED BY THE ENGINEER.
- FOR CATCHPITS CONSTRUCTED ON OR ADJACENT TO A FOOTPATH, STEEL GRATINGS (SEE DETAIL 'A' ON STD. DRG. NO. C2405) OR CONCRETE COVERS (SEE STD. DRG. NO. C2407) SHALL BE PROVIDED AS DIRECTED BY THE ENGINEER.
- 9. IF INSTRUCTED BY THE ENGINEER, HANDRAILING (SEE DETAIL 'G' ON STD. DRG. NO. C2405; EXCEPT ON THE UPSLOPE SIDE) IN LIEU OF STEEL GRATINGS OR CONCRETE COVERS CAN BE ACCEPTED AS AN ALTERNATIVE SAFETY MEASURE FOR CATCHPITS NOT ON A FOOTPATH NOR ADJACENT TO IT. TOP OF THE HANDRAILING SHALL BE 1 000 mm MIN. MEASURED FROM THE ADJACENT GROUND LEVEL.
- 10. MINIMUM INTERNAL CATCHPIT WIDTH SHALL BE 1 000 mm FOR CATCHPITS WITH A HEIGHT EXCEEDING 1 000 mm MEASURED FROM THE INVERT LEVEL TO THE ADJACENT GROUND LEVEL. AND, STEP IRONS (SEE DSD STD. DRG. NO. DS1043) AT 300 ℃ STAGGERED SHALL BE PROVIDED. THICKNESS OF CATCHPIT WALL FOR INSTALLATION OF STEP IRONS SHALL BE INCREASED TO 150 mm.
- FOR RETROFITTING AN EXISTING CATCHPIT WITH STEEL GRATING, SEE DETAIL 'F' ON STD. DRG. NO. C2405.
- SUBJECT TO THE APPROVAL OF THE ENGINEER, OTHER MATERIALS CAN ALSO BE USED AS COVERS / GRATINGS.

- FORMER DRG. NO. C2406J. Original Signed 03.2015
REF. REVISION SIGNATURE DATE

CIVIL ENGINEERING AND
DEVELOPMENT DEPARTMENT


CATCHPIT WITH TRAP (SHEET 2 OF 2)

卓越工程 建設香港

 SCALE 1:20
 DRAWING NO.


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We Engineer Hong Kong's Development

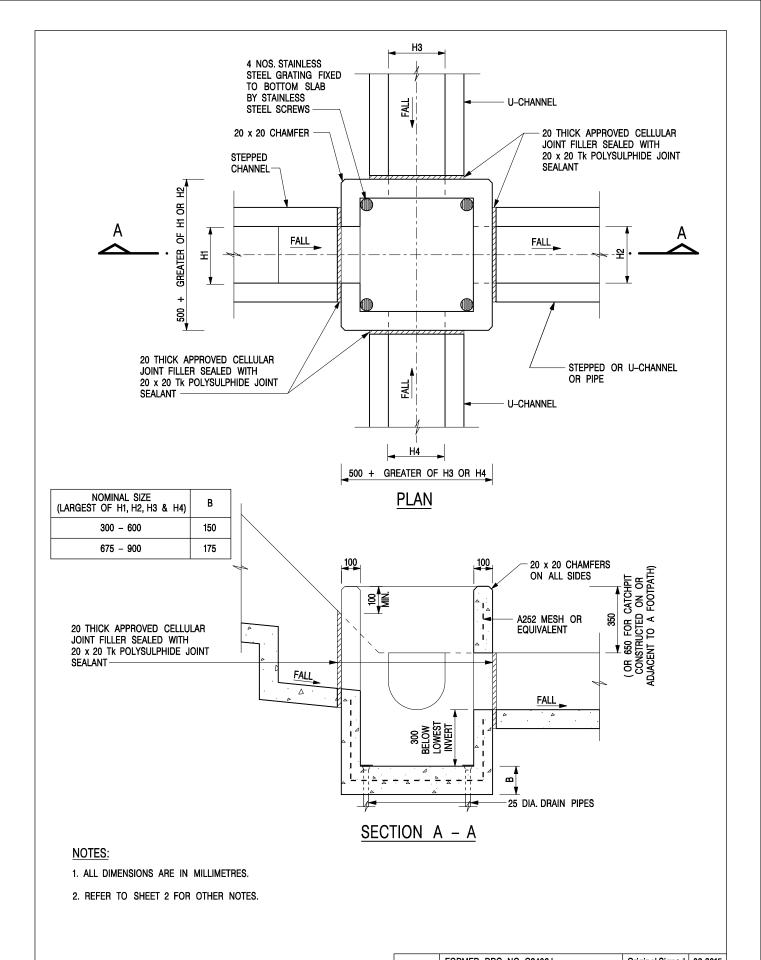


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	REF.	REVISION	SI	IGNATURE	DATE	
CATCHPIT WITH TRAP		CIVIL ENGINEERING AND DEVELOPMENT DEPARTMENT				
(SHEET 1 OF 2)		. E 1 : 20	DRAWING NO.			
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		We Engineer Hong Kong's Development				

APPENDIX SITE PHOTO



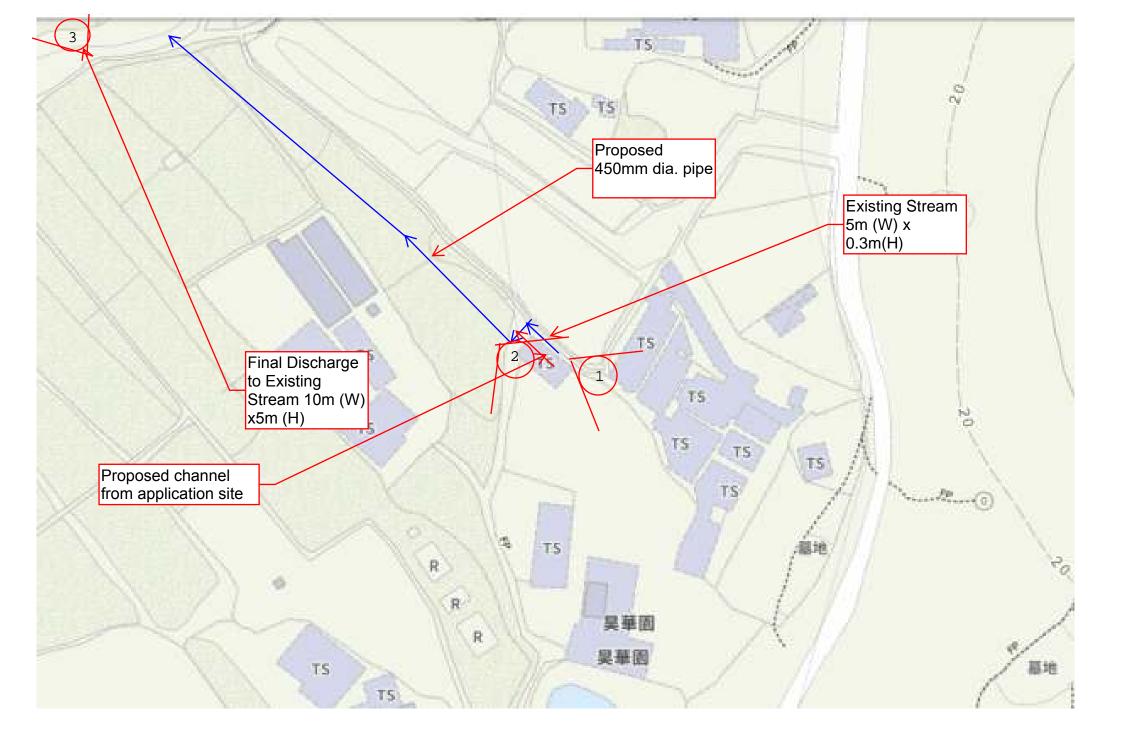

VIEW 1 EXISTING STREAM

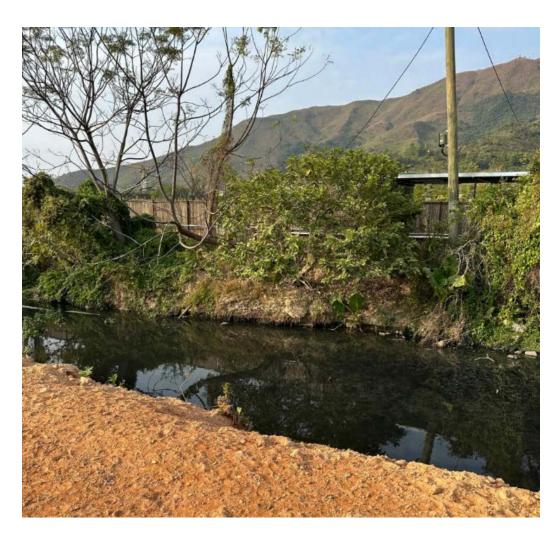

VIEW 2 FINAL DISCHARGE POINT



VIEW 3 Proposed underground pipe and catchpit location